	PLUMI	BING LEGEND		
SYMBOL	DESCRIPTION	SYMBOL	DESCRIPTION	
Ф	BALL VALVE		DIRECTION OF SLOPE	
——————————————————————————————————————	BUTTERFLY VALVE		DIRECTION OF FLOW	
\	GATE VALVE	───	PIPE UP PIPE DOWN	
<u>*</u>	ANGLE GATE VALVE	_	PIPE DROP	
* _* * _	OS & Y GATE VALVE		TOP CONNECTION — BRANCH LINE BOTTOM CONNECTION — BRANCH LINE	
TS ATS	OS & Y GATE VALVE WITH TAMPER SWITCH	——— F ———	FIRE MAIN	
%	SOLENOIDE VALVE	AS	AUTOMATIC WET SPRINKLER COLD WATER	
	LUBRICATED PLUG VALVE		HOT WATER (120°F)	
\	CHECK VALVE		HOT WATER CIRC (120°F) HOT WATER (140°F)	
×		——————————————————————————————————————	HOT WATER CIRC (140'F)	
~~~~~~~~~~~~~~~~~~~~~~~~~~~~~~~~~~~~~~	PRESSURE REDUCING VALVE	SAN	SANITARY SEWER	
φ ‡ <del>*****</del>	RELIEF VALVE	SD	STORM DRAIN PIPING BELOW GRADE	
<b>≯</b> ———	VACUUM RELIEF VALVE PRESSURE & TEMPERATURE RELIEF VALVE		WASTE	
Ť	PRESSURE & TEMPERATURE RELIEF VALVE		VENT	
育	AUTOMATIC AIR VENT		ROOF DRAIN PIPING OVERFLOW DRAIN PIPING	
	CIRCUIT SETTER	——— PD ———	PUMPED DISCHARGE	
	BACKWATER VALVE	D	INDIRECT DRAIN LINE	
DDCV	DOUBLE DETECTOR CHECK VALVE ASSEMBLY		INDUSTRIAL WASTE	
DCV-	DOUBLE CHECK VALVE ASSEMBLY	G	GREASY WASTE NATURAL GAS (7"W.C.)	
	REDUCED PRESSURE BACKFLOW PREVENTER	MG	MEDIUM PRESSURE GAS (2#)	
Tes	PRESSURE SWITCH	——————————————————————————————————————	PROCESS COMPRESSED AIR	
T _{FA}	FLOW ALARM	——— (E) ————	EXISTING PIPE  PIPING TO BE REMOVED	
T _{FS}	FLOW SWITCH	\(\times\)	WASTE STACK	
	UNION			
<del></del>	STRAINER	$\left(\begin{array}{c}v\end{array}\right)$	VENT STACKS	
	STRAINER WITH BLOW OFF	CW		
<del>X</del>	PIPE ANCHOR PIPE ALIGNMENT GUIDE		COLD WATER RISER	
	EXPANSION JOINT	HW	HOT WATER RISER	
<del></del>	FLEXIBLE CONNECTOR			
	CAP OR PLUG	HWC	HOT WATER RECIRC. RISER	
<del></del>	BLIND FLANGE CONCENTRIC REDUCER	G	NATURAL GAS RISER	
—— <del>и</del>	ECCENTRIC REDUCER			
Y WHA	AQUASTAT	RD	RAINWATER LEADER	
P ^{WHA}	WATER HAMMER PRESSURE GAUGE WITH COCK	OD	OVERFLOW DRAIN LEADER	
T BT	THERMOMETER	CA	AND PROPERTY AND PROPERTY.	
; co	CLEANOUT PLUG		COMPRESSED AIR RISER	
FC0 <del> </del>	FLOOR CLEANOUT	AS	AUTOMATIC WET SPRINKLER RISER	
YCO +	YARD CLEANOUT	ASD		
<b>*</b> π	TEST TEE		AUTOMATIC SPRINKLER DRAIN	
<b>─⊞</b> wн	WALL HYDRANT	WSP	WET STANDPIPE RISER	
─# HB	HOSE BIBB YARD HYDRANT		PLUMBING EQUIPMENT	
	THRUST BLOCK		MISCELLANEOUS EQUIPMENT	
•				
FDC }— ⊗—	FIRE DEPARTMENT CONNECTION  FIRE RISER	(#)	SHEET NOTE	
FDV +o	FIRE DEPARTMENT VALVE			
+0	FIRE DEPARTMENT VALVE CABINET			
₹	SIEMESE FIRE DEPT. CONN.			
	FIRE ALARM BELL			
Ø FD ▼ FS	FLOOR DRAIN			
FS ©	FLOOR SINK HUB DRAIN			
❸	FIRE RISER			

```
ABBREVIATIONS
       SQUARE FEET
       POINT OF CONNECTION
       POUNDS
       NUMBER
       PER
ABV
       AMERICANS WITH DISABILITIES ACT
ADA
AFF
       ABOVE FINISHED FLOOR
       ABOVE FINISHED GRADE
       ACCESS PANEL
ARCH
      ARCHITECT
       AUTOMATIC FIRE SPRINKLER SYSTEM
BEL
BFV
       BUTTERFLY VALVE
       BRAKE HORSEPOWER
BTU
       BRITISH THERMAL UNIT
       BALL VALVE
BWV
       BACKWATER VALVE
       COMPRESSED AIR
       CONDENSATE DRAIN
CFF
       CAP FOR FUTURE
CFH
      CUBIC FEET PER HOUR
CFM CUBIC FEET PER MINUTE
CFS
      CUBIC FEET PER SECOND
       CAST IRON
CLG
CO
       CLEANOUT
CONC CONCRETE
CONTR CONTRACTOR
CONT
       CONTINUATION
CS
      CIRCUIT SETTER
CV
       CHECK VALVE
CW
       COLD WATER
CWFU COLD WATER FIXTURE UNIT
DN
       DOWN
DCVA DOUBLE CHECK VALVE ASSEMBLY
DDCVA DOUBLE DETECTOR CHECK VALVE ASSEMBLY
DFU
       DRAINAGE FIXTURE UNIT
HWC
       HOT WATER CIRC
DIA
       DIAMETER
DSN
       DOWNSPOUT NOZZLE
      DRY STANDPIPE SYSTEM
DWV
       DRAINAGE WASTE AND VENT
EXIST
      EXISTING
ELEC
      ELECTRICAL
FA
      FLOW ALARM
       FLEXIBLE CONNECTION
      FLOOR CLEANOUT
      FIRE DEPARTMENT CONNECTION
FDVC
       FIRE DEPARTMENT VALVE CABINET
FH
       FIRE HYDRANT
FIN
      FINISHED
       FLOOR
FM
       FROM
      FUEL OIL
FO
FPS
      FEET PER SECOND
FT
      FEET
FU
      FIXTURE UNIT
GD
      GARBAGE DISPOSER
      GALLONS PER HOUR
GPM
      GALLONS PER MINUTE
      GATE VALVE
HD
       HUB DRAIN
HP
       HORSEPOWER
HW HOT WATER
HWFU HOT WATER FIXTURE UNIT
IAPMO INTERNATIONAL ASSOCIATION OF PLUMBING AND PLUMBING OFFICIALS
ICBO INTERNATIONAL CONFERENCE OF BUILDING OFFICIALS
I.E. INVERT ELEVATION
LBS POUNDS (UNIT OF FORCE)
LPV LUBRICATED PLUG VALVE
MAX MAXIMUM
MBH THOUSANDS BTU/HR
MECH PLUMBING
MFG
      MANUFACTURER
MIN
      MINIMUM
MH MANHOLE
N.C. NORMALLY CLOSED
NFPA NATIONAL FIRE PROTECTION ASSOCIATION
NO. NUMBER
N.O. NORMALLY OPEN
NIC NOT IN CONTRACT
OFCI OWNER FURNISHED CONTRACTOR INSTALLED
OW OIL WASTE
POC POINT OF CONNECTION
PLBG PLUMBING
PS PRESSURE SWITCH
PSI POUNDS PER SQUARE INCH
PT PRESSURE TEMPERATURE TRAP (PETE'S PLUG)
PV PLUG VALVE
R,I,&C ROUGH IN AND CONNECT
RPBFP REDUCED PRESSURE PRINCIPLE BACKFLOW PREVENTER
RPM REVOLUTIONS PER MINUTE
      SQUARE FEET
SHT SHEET
SN SHEET NOTE
SOPSC STATE OF PLUMBING SPECIALTY CODE
SOSSC STATE OF STRUCTURAL SPECIALITY CODE
SOV SHUT-OFF VALVE
SPKR SPRINKLER
TB THRUST BLOCK
      THERMOSTATIC MIXING VALVE
       TRAP PRIMER
       TAMPER SWITCH
TT
       TEST TEE
TYP
       TYPICAL
UN
       UNION
VB
       VACUUM BREAKER
       VENT
       VOLTS
```

VTR

W

W/

WGT

WSP

YB

WCO

VENT THROUGH ROOF

WALL CLEANOUT

WET STANDPIPE

YARD BOX

WASTE

WITH

# PLUMBING DRAWING LIST

P.01 PLUMBING LEAD SHEET P.02 PLUMBING SCHEDULES P2.0 PLUMBING PLAN ENLARGED P2.1 PLUMBING PLANS

P2.2 PLUMBING ROOF PLAN

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3 05/07/12 PLAN CHECK 1 2 03/06/12 ADDENDUM 3 NO. DATE BY DESCRIPTION

REVISIONS

PLAN CHECK CORRECTIONS

05/07/2012 DRAWING NO. 6693

**PLUMBING** 

**LEAD SHEET** 

			PL	UMBII	NG FI	XTUF	RES SCHEDULE
ITEM	DESCRIPTION	TRAP arm	WASTE	VENT	CW	HW	REMARKS
WC-1	WATER CLOSET 1.28 GPF, FT	INT	4"	2"	1-1/2"		"AMERICAN STANDARD" MODEL # 3351.128 "AFWALL" ELONGATED WALL MOUNT, 1.28 GPF TOILET WITH "SLOAN" ROYAL MODEL #111-1.28 HIGH-EFFICIENCY MANUAL FLUSHOMETER VALVE, 1.28 GPF, OLSONITE #95 OPEN FRONT ONSONITE #95CC-SS SEAT LESS COVER
WC-2	WATER CLOSET 1.28 GPF — FT — ADA	INT	4"	2"	1-1/2"		"AMERICAN STANDARD" MODEL # 3351.128 "AFWALL" ELONGATED WALL MOUNT, 1.28 GPF TOILET WITH "SLOAN" ROYAL MODEL #111-1.28 HIGH-EFFICIENCY MANUAL FLUSHOMETER VALVE, 1.28 GPF, OLSONITE #95 OPEN FRONT ONSONITE #95CC-SS SEAT LESS COVER
U-1	URINAL 1.28 GPF — FT — ADA	INT	2"	2"	1-1/2"		"SLOAN" #WES-1000.1001-0.13 WALL HUNG HEU URINAL, WITH "SLOAN" MODEL # WEUS-1000.1201-0.13 SOLIS, SOLAR POWERED HEU FLUSHOMETER.
L-1	LAVATORY ADA	1¼"	2"	1½"	1/2"	1/2"	"AMERICAN STANDARD" 0356.028 "LUCERNE" VITREOUS CHINA, WALL HUNG, 8" CENTERS. FAUCET: 0.5 GPM. STOPS BRASSCRAFT #ST-CR19 W/ BC #5130 SUPPLIES. ADA COMPLIANCE.
L-2	LAVATORY ADA	1¼"	1½"	1½"	½"	1/2"	"KOHLER" LADENA MODEL #K2214 VITREOUS CHINA, WITH OVERFLOW WALL HUNG, 8" CENTERS. FAUCET: SLOAN SOLIS 0.5 GPM. STOPS BRASSCRAFT #ST-CR19 W/ BC #5130 SUPPLIES. ADA COMPLIANCE. COLOR TO BE SELECTED
SS-1	SERVICE SINK	3"	3"	2"	₹4"	3/4"	"FLOORSTONE", MODEL # 80. FAUCET: "JUST" #JVB-1200, WALL MOUNT, VACUUM BREAKER SPOUT W/ PAIL HOOK AND WALL BRACE AND 3/4" MALE THREADED OUTLET.
S-1	SINK	2"	2"	2"	3/4"	3/4"	"JUST" MODEL # S-L-ADA-2233-A-GR, COUNTER MOUNT SINGLE 5" DEEP BOWL, 18 GAUGE TYPE 304, 18-8, STAINLESS STEEL. W/ CENTER REAR DRAIN. FAUCET: GROHE, MINTA #32319 DUAL SPRAY PULL DOWN.
S-2	SINK	2"	2"	2"	34"	3/4"	"JUST" MODEL # HCL-23520-S WALL MOUNTED SINK. WITH SENSOR OPERATED FAUCET. ADA COMPLIANT. FAUCET: "JUST" MODEL # JSGN-AAC SENSOR OPERATED FAUCET WITH CONTROL MODULE.
FD-1	FLOOR DRAIN	2"/3"	2"/3"	1½"			"J.R. SMITH" 2005(-SS) WITH TRAP PRIMER CONNECTION. TRAP PRIMER MAY BE PROVIDED BY A FLUSH VALVE ATTACHEMENT OR A "PPP" PR-500 RECESSED IN WALL BEHIND ACCESS PANEL WITH A 1/2" BALL VALVE PRECEEDING THE TRAP PRIMER, BOTH BEHIND ONE ACCESS PANEL.
EWC-1	ELECTRIC WATER COOLER	2"	2"	2"	1/2"	_	"HAWS" #1011, "HI-LO" BARRIER FREE DUAL HEIGHT, WALL MOUNTED, 18 GAUGE, TYPE 304 STAINLESS STEEL, PUSH-BUTTON VALVES FRONT ACCESSIBLE S/S BACK PANEL AND LOUVERED GRILL WITH #6426 IN-LINE FILTER. 120 VOLT.
DF-1	DRINKING FOUNTAIN	-	-	-	1/2"	-	W/DRY WALL
TP-1	PRESSURE DROP TRAP PRIMER				1/2"		PPP #P-2, COPPER BODY COMPLETE 1/2" COPPER TYPE "L" PIPE TO RECECPTOR(S). INSTALL PER MANUF. RECOMMENDATIONS AND PROVIDE ACCESS PANEL
HB-1	HOSE BIBB				3/4"		"J.R. SMITH" #5906 NON FREEZE ROOF HYDRANT.
HB-2	HOSE BIBB				3/4"		"J.R. SMITH" #5810 NON FREEZE GROUND HYDRANT.
GD-1	GARBAGE DISPOSER						"IN-SINK-ERATOR" MODEL # SS-50. 1/2 HP DISPOSER.
	•		•		-		

				GAS	WAT		EATER	SCHEDU	JE	
ITEM	LOCATION	SERVICE	TYPE	HOT WATER CAPACITY AT 60°F	BTU/HR INPUT	ELECT VOLT	RICAL DATA  HZ	MANUFACTURER & MODEL NO.	OPERATING WEIGHT LBS.	REMARKS
GWH 1	ROOF	DOMESTIC HOT WATER	TANKLESS/ OUTDOOR	4.8 GPM	199,000	120	60	NORITZ NC 199-OD	110	23.6"(HEIGHT) X 13.8"(WIDTH) X 10.6"(DEPTH), SC-201-6M MULTI-SYSTEM CONTROLLER (SINGLE MANIFOLD), 120 VAC. SET @ 122°F
GWH 2	ROOF	DOMESTIC HOT WATER	TANKLESS/ OUTDOOR	4.8 GPM	199,000	120	60	NORITZ NC199-OD	110	23.6"(HEIGHT) X 13.8"(WIDTH) X 10.6"(DEPTH), SC-201-6M MULTI-SYSTEM CONTROLLER (SINGLE MANIFOLD), 120 VAC.

PUMP SCHEDULE											
ITEM	SERVICE	MANUFACTURER AND MODEL	TYPE -	GPM	CAPACITY HEAD, FT	HP	RPM	VOLTS	PHASE	WGT	REMARKS
CPR 1	HOT WATER GWH-1	B&G SERIES PR	INLINE	5	15	1/6	1750	120	1	50	INLINE CIRCULATING PUMP FOR DOMESTIC HOT WATER WITH TC-1 (AUTOMATIC TIMER KIT) AND AQ (AQUATAT).

	EXPANSION TANK SCHEDULE									
ITEM	SERVICE	MANUFACTURER AND MODEL	TANK VOL.	OPER. WT.	MAX. TEMP	DIMENSIONS	REMARKS			
ET 1	DOMESTIC HOT WATER GWH-1	WATTS PLT-5	2.1 GAL	5.5 LBS	200°F	8" DIA., 11" LONG	DRAWN STEEL W/BUTYL DIAPHRAGM			
ET 2	DOMESTIC HOT WATER GWH-2	WATTS PLT-5	2.1 GAL	5.5 LBS	200°F	8" DIA., 11" LONG	DRAWN STEEL W/BUTYL DIAPHRAGM			

	PIPE	SIZE C	HART			
SIZE		CW	HW			
SIZE	F.V.	F.T.	F.T.			
1/2"	0	1	1			
3/4"	0	6	6			
1"	0	13	13			
1-1/4"	0	24	24			
1-1/2"	10	47	47			
2"	64	158	120			
2-1/2"	245	380	246			
3"	630	691	412			
MAX. VELOCITY MAX. VELOCITY C.W.(8 F.P.S.) H.W.(5 F.P.S.)						

ALL PIPE SIZING BASED ON 3.0 PSI PER 100 FT. FRICTION LOSS.

		MATERIALS // // // //
SERVICE	LOCATION SSS	FITTINGS
WATER	INSIDE  OUTSIDE	LEAD FREE SOLDERED FITTINGS  LEAD FREE SOLDERED FITTINGS
WASTE	ABV. FLR.  BEL. GRADE	TYLER 4-BAND NO-HUB COUPLINGS
VENT	ABV. FLR. BEL. GRADE	TYLER 2-BAND NO-HUB COUPLINGS TYLER 2-BAND NO-HUB COUPLINGS
STORM DRAIN	ABV. FLR.  BEL. GRADE	TYLER 4-BAND NO-HUB COUPLINGS  TYLER 4-BAND NO-HUB COUPLINGS
CONDENSATE	INSIDE •	LEAD FREE SOLDERED FITTINGS
DRAIN  NATURAL GAS	OUTSIDE	LEAD FREE SOLDERED FITTINGS  SCHEDULE 40 THREADED FITTINGS
	OUTSIDE	SCHEDULE 40 THREADED FITTINGS

WATER FIXTURE 2010 CPC		DRAINAGE FIXTURE UNIT CHART 2010 CPC & UPC.				
FIXTURE	CW FU	HW FU	FIXTURE	FU		
(WATER CLOSET) FLUSH VALVE	5	_	WC (WATER CLOSET)	4		
(LAVATORY)	1	1	L (LAVATORY)	1		
(SINK)	2	2	S (SINK)	2		
S (SERVICE SINK)	3	3	SS (SERVICE SINK)	3		
(HOSE BIBB)	2.5	_	FD	2		
CH ADDITIONAL HB	1		FS	1		

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05/07/12 PLAN CHECK 1
2 03/06/12 ADDENDUM 3
1 02/21/12 ADDENDUM 2
NO. DATE BY DESCRIPTION
REVISIONS

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DATE 05/07/2012 DRAWING NO. 6693

PLUMBING SCHEDULES

LIBRA BRANCH

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**PLUMBING** 

**PLAN** 

PLUMBING PLAN

SCALE: 1/4"=1'-0"

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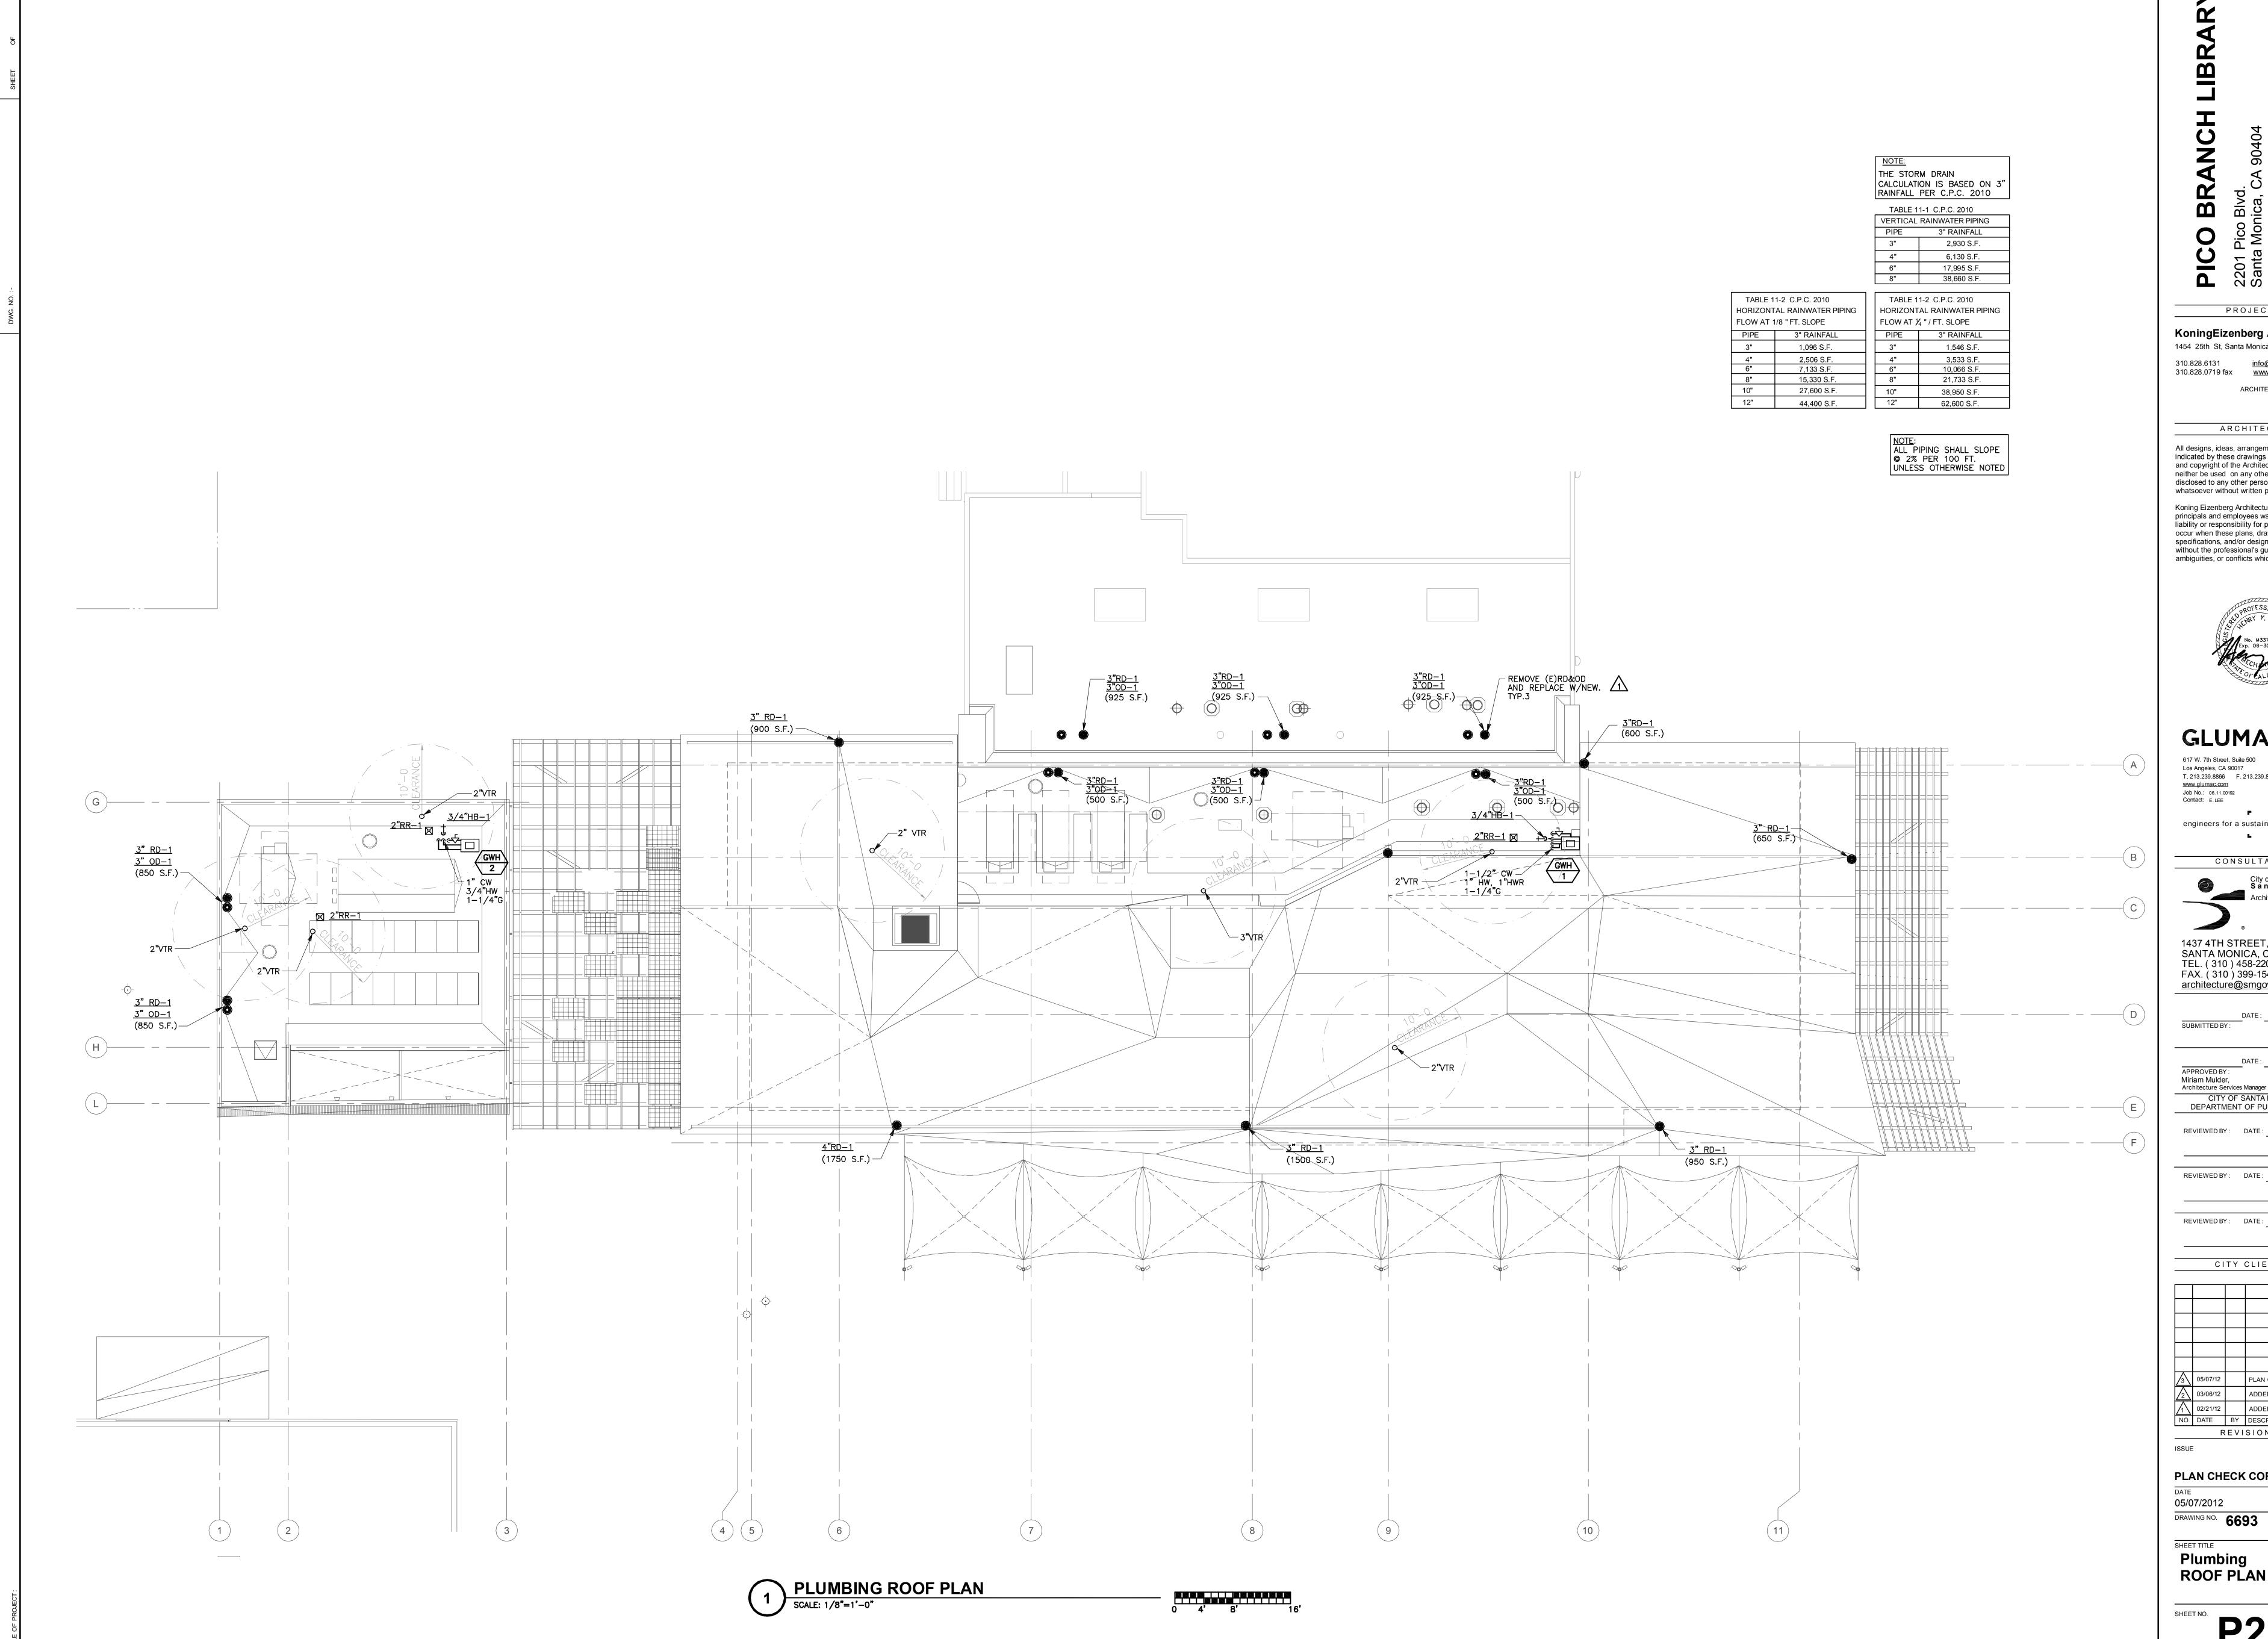
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SHEET TITLE **ENLARGED PLUMBING** 

**PLANS** 



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**Plumbing ROOF PLAN**